FARRAGUT RESIDENCE

100 Summit Street, Philadelphia, PA, USA

OWNER


Ryan & Kerri Farragut

100 Summit Street Philadelphia, PA

ARCHITECT

KRIEGER + ASSOCIATES ARCHITECTS

14 WEST HIGHLAND AVENUE PHILADELPHIA, PA 19118

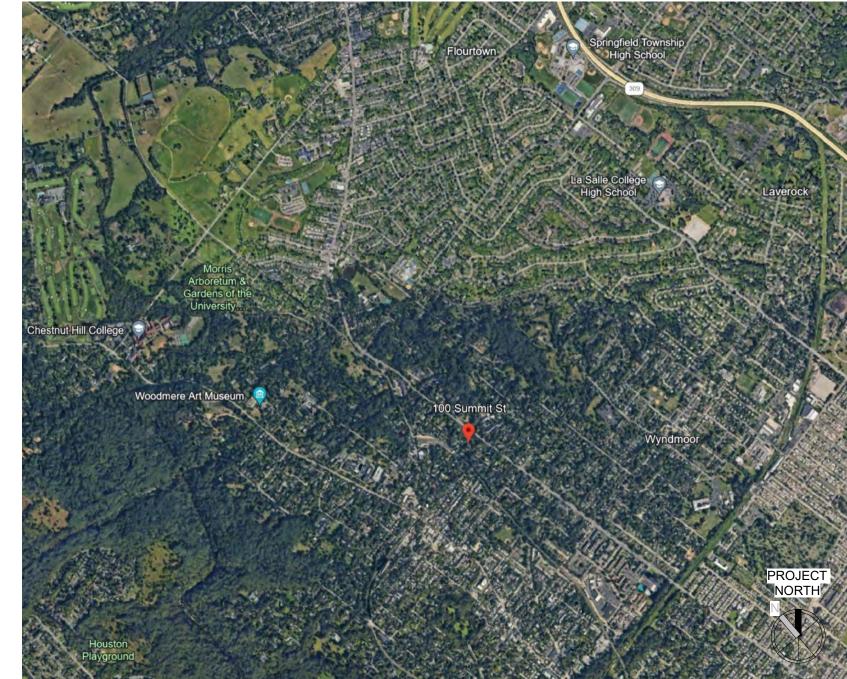

SITE LOCATION MAP

PARALLEL STRAND LUMBER


GENERAL DRAWING NOTES

- IN CASE OF CONFLICT BETWEEN DRAWINGS AND SPECIFICATIONS, THE MORE
- AND/OR DEVIATIONS FROM DRAWINGS. PROPOSED REMEDIES, IF REQUIRING ADDITIONAL WORK, ARE TO BE SUBMITTED FOR APPROVAL IN THE FORM OF WRITTEN CONTRACT BEFORE ORDERING MATERIAL OR COMMENCING WITH WORK.
- WRITTEN DIMENSIONS HAVE PRECEDENCE OVER SCALED DIMENSIONS. ITEMS NOT NOTED AS EXISTING ARE PROPOSED. DOORS AND WINDOWS NOT NUMBERED ON THE FLOOR PLANS OR ELEVATIONS ARE EXISTING TO REMAIN, UNLESS
- ALL DIMENSIONS TO EXISTING SURFACES ARE TO FINISH, UNLESS NOTED OTHERWISE.
- MECHANICAL, ELECTRICAL, PLUMBING AND FIRE PROTECTION SYSTEMS ARE INDICATED ON ARCHITECTURAL DRAWINGS FOR COORDINATION ONLY.
- THIS PROJECT HAS BEEN DESIGNED USING THE 2018 INTERNATIONAL RESIDENTIAL CODE (IRC), AND APPLICABLE LOCAL REGULATIONS.

SPECIAL INSPECTION NOTES

- SPECIAL INSPECTIONS ARE REQUIRED BY THE INTERNATIONAL BUILDING CODE FOR THIS PROJECT. SEE STATEMENT OF SPECIAL INSPECTIONS SCHEDULE FOR A LIST OF THE REQUIRED INSPECTIONS, AND FREQUENCY BY WHICH INSPECTIONS ARE TO BE CONDUCTED.
- IT IS THE OWNER'S RESPONSIBILITY TO RETAIN THE SERVICES OF A THIRD-PARTY SPECIAL INSPECTOR TO PERFORM SPECIAL INSPECTIONS. THE INSPECTION AGENCY MAY NOT BE THE DESIGN ARCHITECT OR STRUCTURAL ENGINEER OF RECORD TO AVOID CONFLICTS OF INTEREST. THE SPECIAL INSPECTION AGENCY MUST BE IAS ACCREDITED AND PRE-QUALIFIED BY THE CITY OF PHILADELPHIA TO PERFORM THE REQUIRED INSPECTIONS.
- THE STRUCTURAL ENGINEER OF RECORD IS TO BE THE DESIGN PROFESSIONAL IN RESPONSIBLE CHARGE OF SPECIAL INSPECTIONS (DPRC-SI). THE DPRC-SI IS RESPONSIBLE FOR THE FOLLOWING:
 - IDENTIFYING REQUIRED SPECIAL INSPECTIONS
 - SUBMITTING STATEMENT OF SPECIAL INSPECTIONS
- EVALUATING AND SELECTING A SPECIAL INSPECTIONS AGENCY REPORTING NON-COMPLIANCE ISSUES TO THE CONTRACTOR AND TO L&I FOR
- ISSUES THAT ARE HAZARDOUS TO LIFE, SAFETY OR HEALTH. REVIEWING AND APPROVING SPECIAL INSPECTIONS PROGRESS REPORTS AND FINAL REPORTS.
- IT IS THE CONTRACTOR'S RESPONSIBILITY TO SCHEDULE SPECIAL INSPECTIONS, AND TO MAINTAIN CONTRACT DOCUMENTS ON-SITE FOR USE BY THE SPECIAL INSPECTOR. 48 HOURS NOTICE IS REQUIRED FOR FIELD INSPECTIONS, AND 7 DAYS NOTICE IS REQUIRED
- A PRE-CONSTRUCTION MEETING IS RECOMMENDED TO DISCUSS SPECIAL INSPECTIONS. OWNER, DPRC-SI, ARCHITECT AND SPECIAL INSPECTOR TO ATTEND.

MATERIAL LEGEND

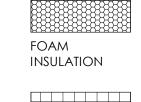

(LARGE SCALE)

CONCRETE

ROUGH WOOD


SHEATHING


(SMALL SCALE)


VENT SPACE /


DRAINAGE PLANE

MASONRY

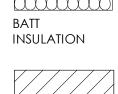


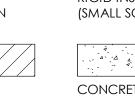


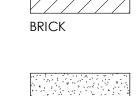


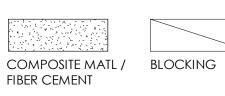




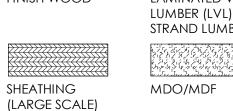

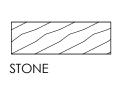


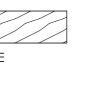




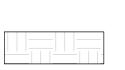


SYMBOL LEGEND

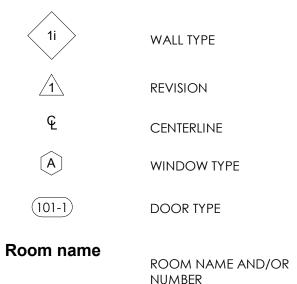

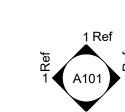





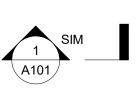





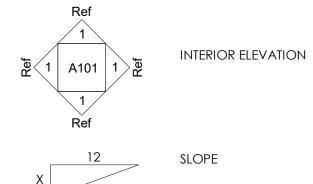

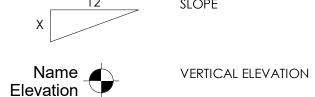



ABBREVIATIONS

| | | 1 L(C) | |
|------------------|--------------------------|-------------|---------------------------|
| ACT | ACOUSTIC CEILING TILE | | EXTINGUISHER (CABINET) |
| ADDN | ADDITIONAL | FEN | FENCE |
| ADJ | ADJACENT | FF | FILTER FABRIC |
| ADJUST | ADJUSTABLE | FG | FIBERGLASS |
| AFF | ABOVE FINISH | FIN | FINISH |
| ¬\I I | FLOOR | FLR | FLOOR |
| ΑL | ALUMINUM | FLUOR | FLUORESCENT |
| ALT | ALTERNATE | FP | FIREPLACE |
| AP | ACCESS PANEL | FT | FOOT |
| APP | APPLIANCE | FTG | FOOTING |
| APPROX | APPROXIMATE | FX | FIXED |
| AWN | AWNING | GA | GAUGE |
| B/O | BOTTOM OF | GALV | GALVANIZED |
| | | | |
| BC | BRICK COURSE(S) | GC | GENERAL CONTRACTOR |
| BD | BOARD | GWB | GYPSUM WALL |
| BDBD | BEAD BOARD | OVVD | BOARD |
| BM | BEAM | Н | HIGH |
| BOD | BASIS OF DESIGN | НВ | HOSEBIB |
| BR | BRUSHED | HDWD | HARDWOOD |
| BSMT | BASEMENT | HM | HOLLOW METAL |
| CANT | CANTILEVER(ED) | HOP | HOPPER |
| CBB | CEMENTITIOUS | HORIZ | HORIZONTAL |
| ~ | BACKER BOARD | horiz HT | |
| CBNT | CABINET | | HEIGHT |
| CI | CASTIRON | HTR | HEATER |
| CJ | CONTROL JOINT | INCAN | INCANDESCENT |
| CL | CENTER LINE | INSUL | INSULATION |
| CLNG | CEILING | INT | INTERIOR |
| CLR | CLEAR | JT | JOINT |
| CMU | CONCRETE MASONRY UNIT | L | LOW |
| COI | | LIN | LINOLEUM |
| COL COMP | COLUMN COMPOSITE | LKG | LOOKING |
| | | LT | LIGHT |
| CONC | CONCRETE | LV LVL | LOW VOLTAGE LAMINATED |
| CONT CONTR | CONTINUOUS | LVL | VENEER LUMBER |
| CPT | CONTRACTOR CARPET | MATL | MATERIAL |
| | CASEMENT | MAX | MAXIMUM |
| CSMT | | MDO | MEDIUM DENSITY |
| CT | CERAMIC TILE | MIDO | OVERLAY |
| DBL DED | DOUBLE DEDICATED | MFGR | MAUFACTURER |
| DEMO | DEMOLITION | MIN | MINIMUM |
| DEMO | DOUBLE HUNG | MO | MASONRY |
| | | | OPENING |
| DIA | DIAMETER DIMENSIONS | MTD | MOUNTED |
| DIMS | DOWN | MTL | METAL |
| DN DS | DOWNSPOUT | NA | NOT APPLICABLE |
| | DETAIL(S) | NIC | NOT IN |
| DTL(S) DWG(S) | DRAWING(S) | | CONTRACT |
| | • • | NTS | NOT TO SCALE |
| EA EJ | EACH EXPANSION | O/A | OVERALL |
| ΞJ | JOINT | O/C | ON CENTER |
| ELEC | ELECTRIC | ОН | OVERHEAD |
| ENG | ENGINEERED | OPER | OPERABLE |
| EQ | EQUAL, | OPNG | OPENING |
| | EQUIVALENT | OPP | OPPOSITE |
| EWC | ELECTRIC WATER | PAF | POWDER |
| | COOLER | | ACTUATED FASTENER |
| -v.c | EVICTIVIO | | IVAIFINEL |

EXISTING

EXT

EXPANSION

FLOOR DRAIN

FOUNDATION

EXTERIOR

| | STRAND LUMBER |
|-------|------------------------------|
| PT | PRESSURE |
| | TREATED |
| R | RISER |
| RAD | RADIUS |
| RAG | RETURN AIR GRIL |
| RCP | REFLECTED CEILING PLAN |
| RECP | RECEPTACLE |
| REF | REFRIGERATOR |
| REQD | REQUIRED |
| RES | RESILIENT |
| RO | ROUGH |
| | OPENING |
| S&R | SHELF & ROD |
| SAG | SUPPLY AIR GRIL |
| SC | SOLID CORE |
| SCHED | SCHEDULE |
| SCR | SCREEN |
| SECT | SECTION |
| SH | SINGLE HUNG |
| SIM | SIMILAR |
| SL | SLIDER |
| SSTL | STAINLESS STEEL |
| ST | STUCCO |
| STD | STANDARD |
| STL | STEEL |
| STN | STONE |
| STR | STRUCTURAL |
| T | TREAD |
| • | TONGUE & |
| T&G | GROOVE |
| T/O | TOP OF |
| TBD | to be determined |
| TE | TEMPERED |
| TYP | TYPICAL |
| U/C | UNDER CABINET |
| U/S | UNDERSIDE |
| UNF | UNFINISHED |
| UNO | UNLES NOTED OTHERWISE |
| VCB | VINYL COVE BASE |
| VCT | VINYL COMPOSITION TILE |
| VERT | VERTICAL |
| VIF | VERIFY IN FIELD |
| VTR | VENT THRU ROO |
| W/ | WITH |
| WD | WOOD |
| WDW | WINDOW |
| WG | WIRE GLASS |
| WH | WATER HEATER |
| VVI 1 | WAILK DEALEK |

WALL PAPER

WELDED WIRE

FABRIC

LAMINATE

PLASTIC

PLASTER

PLYWD PLYWOOD

PLAM

| | SHEET LIST | | | |
|-----------------|-------------------------------|------------------------------------|------------------------------------|----------------------------|
| SHEET NUMBER | SHEET NAME | PRELIMINARY PRICING SET 03.28.24 | ISSUE FOR ZONING PERMIT 08.13.24 | PHC APPLICATION 01.10.25 |
| 0-Genero | NI | <u> </u> | | |
| G0.1 | COVER SHEET | • | • | • |
| G0.2 | PRELIMINARY PRICING SCHEDULE | • | | |
| ZO.1 | SITE PLAN | • | • | • |
| 1-Archite | cture | | | |
| A1.1 | DEMOLITION PLANS & SCHEDULES | • | | • |
| A2.1 | FIRST FLOOR PLAN | | • | • |
| A2.2 | SECOND FLOOR PLAN | | • | • |
| A3.1 | EXTERIOR ELEVATION - ADDITION | • | • | • |
| A3.2 | EXTERIOR ELEVATION - ADDITION | • | • | • |
| A3.3 | EXTERIOR ELEVATION - ADDITION | • | • | • |
| A3.4 | EXTERIOR ELEVATION - GARAGE | • | • | • |
| A3.5 | EXTERIOR ELEVATION - GARAGE | • | • | • |
| A3.6 | EXTERIOR ELEVATION - GARAGE | • | • | • |

A3.7 EXTERIOR ELEVATION - GARAGE

A3.8 BUILDING SECTION - GARAGE

Krieger

ARCHITECT PROJECT NUMBER: ISSUE DATE:


JANUARY 10, 2025 STATUS:


PHC APPLICATION




SHEET TITLE: **COVER SHEET**

SHEET NUMBER:

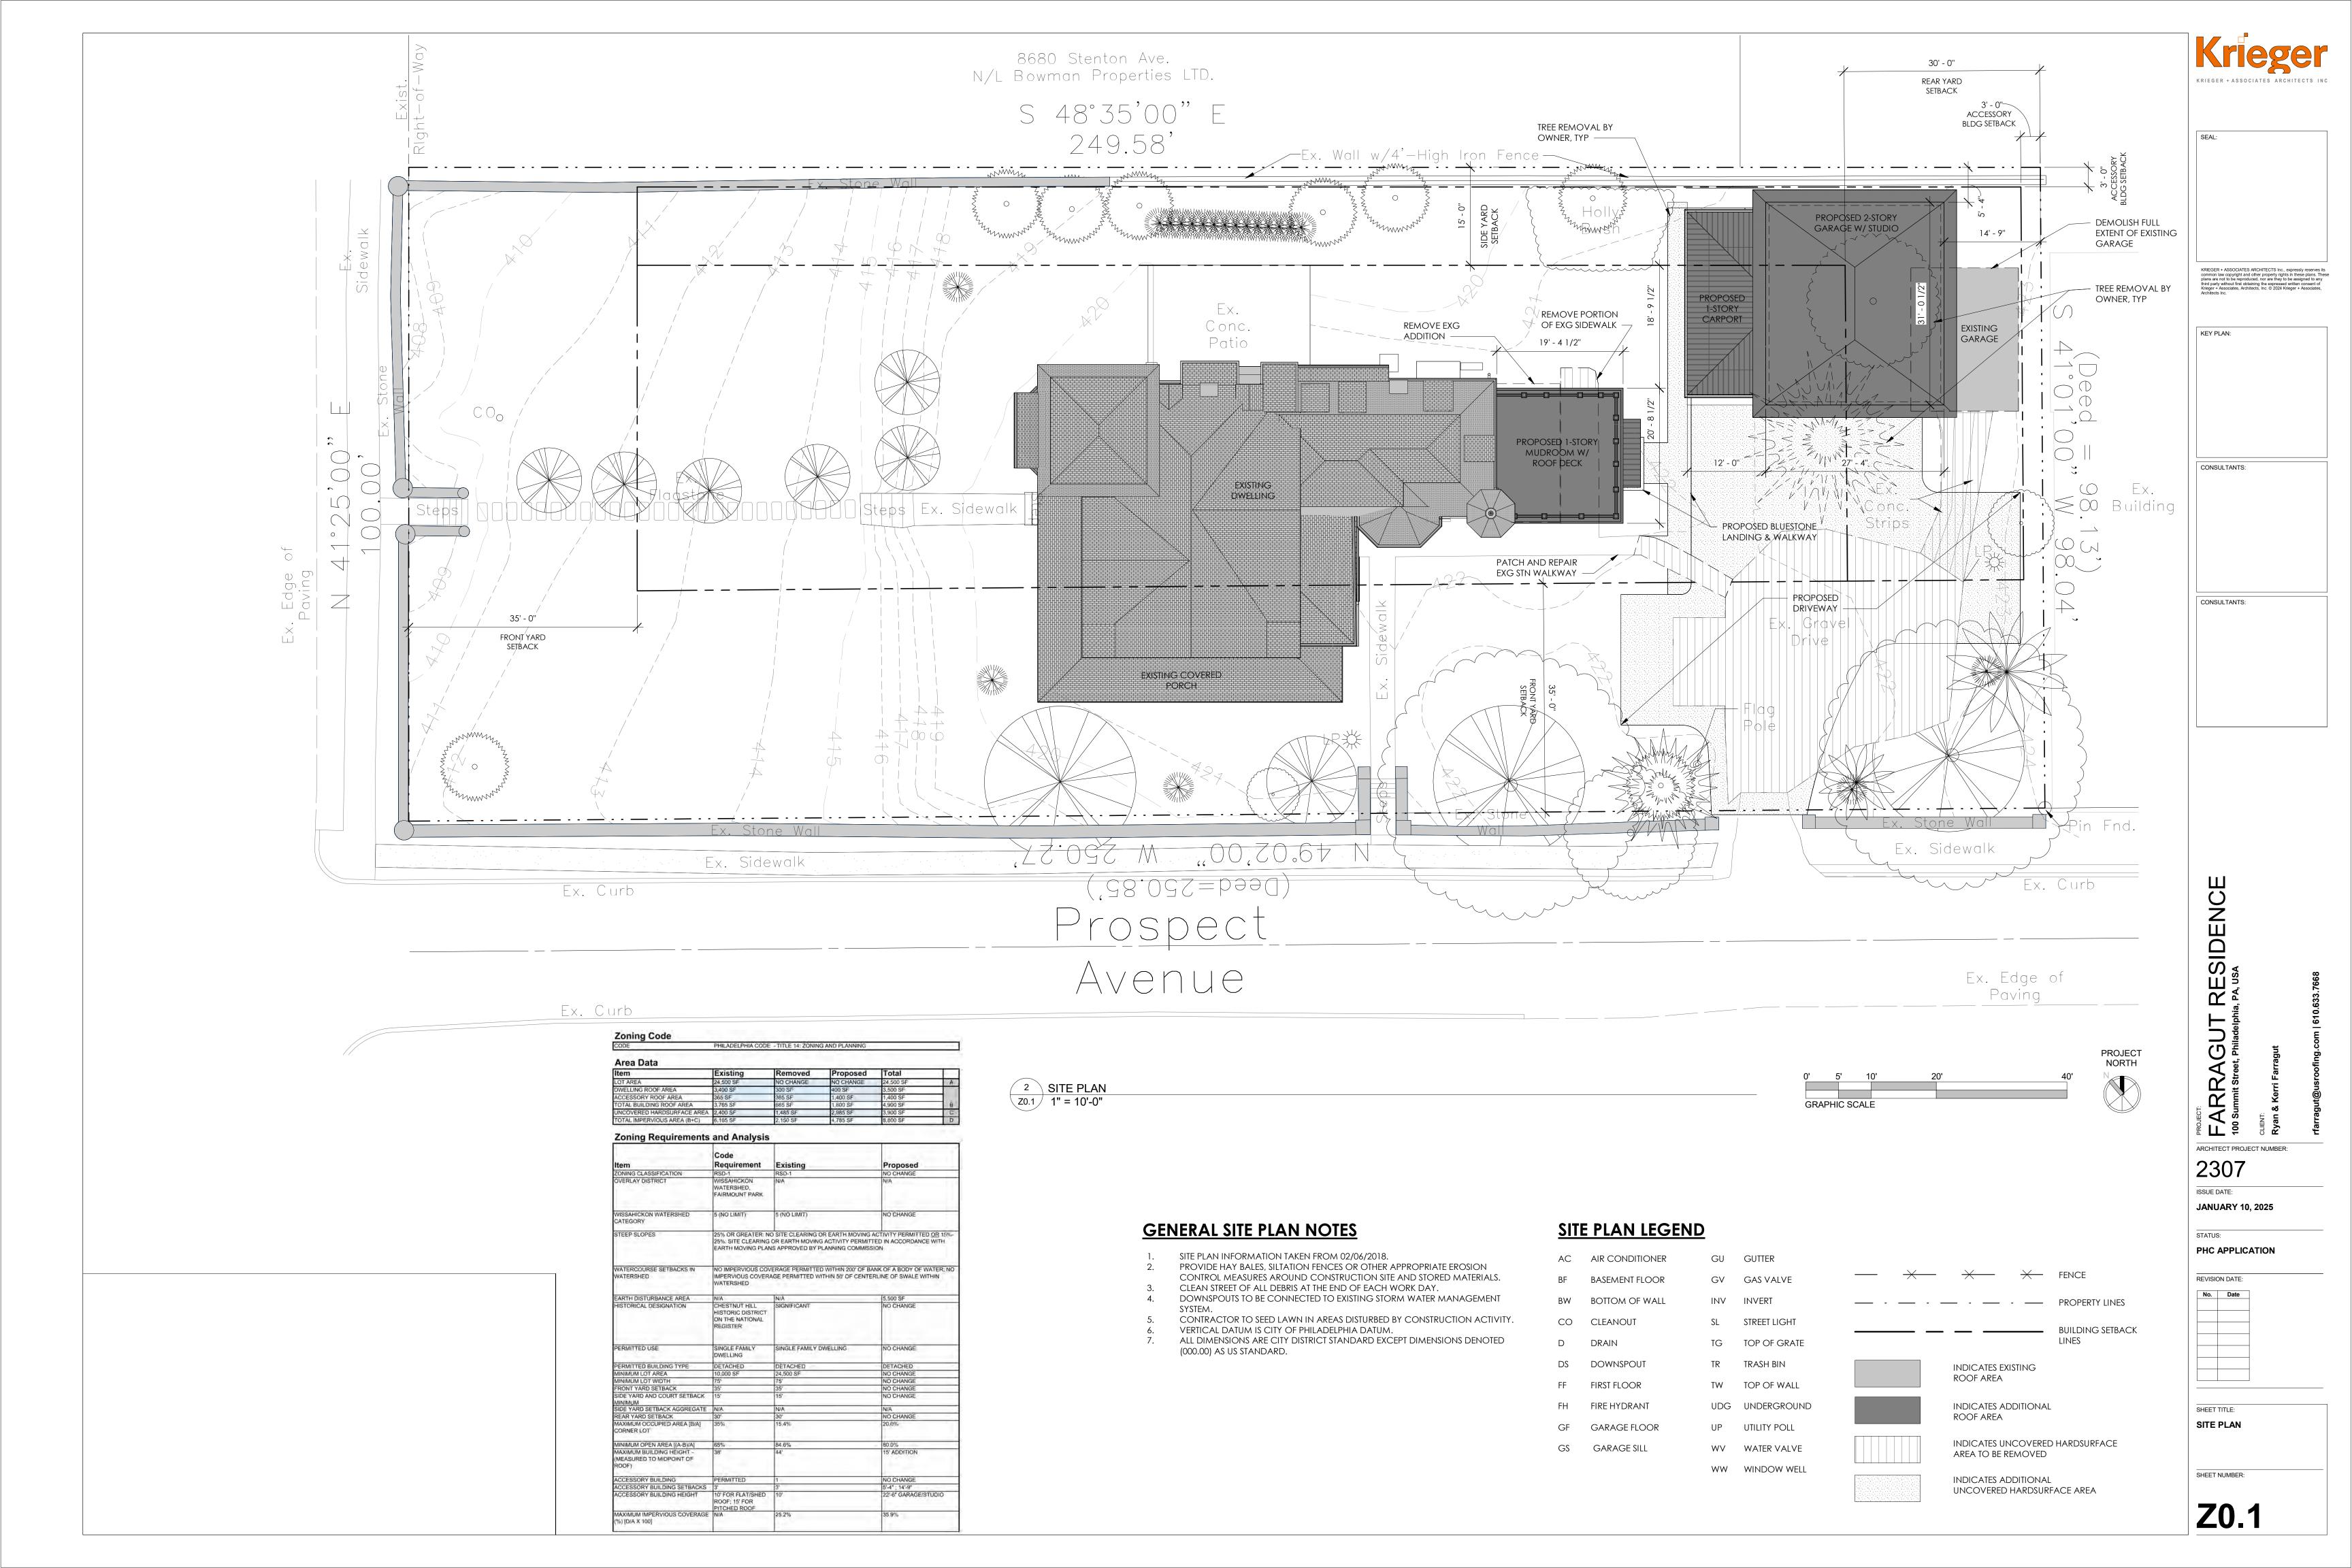

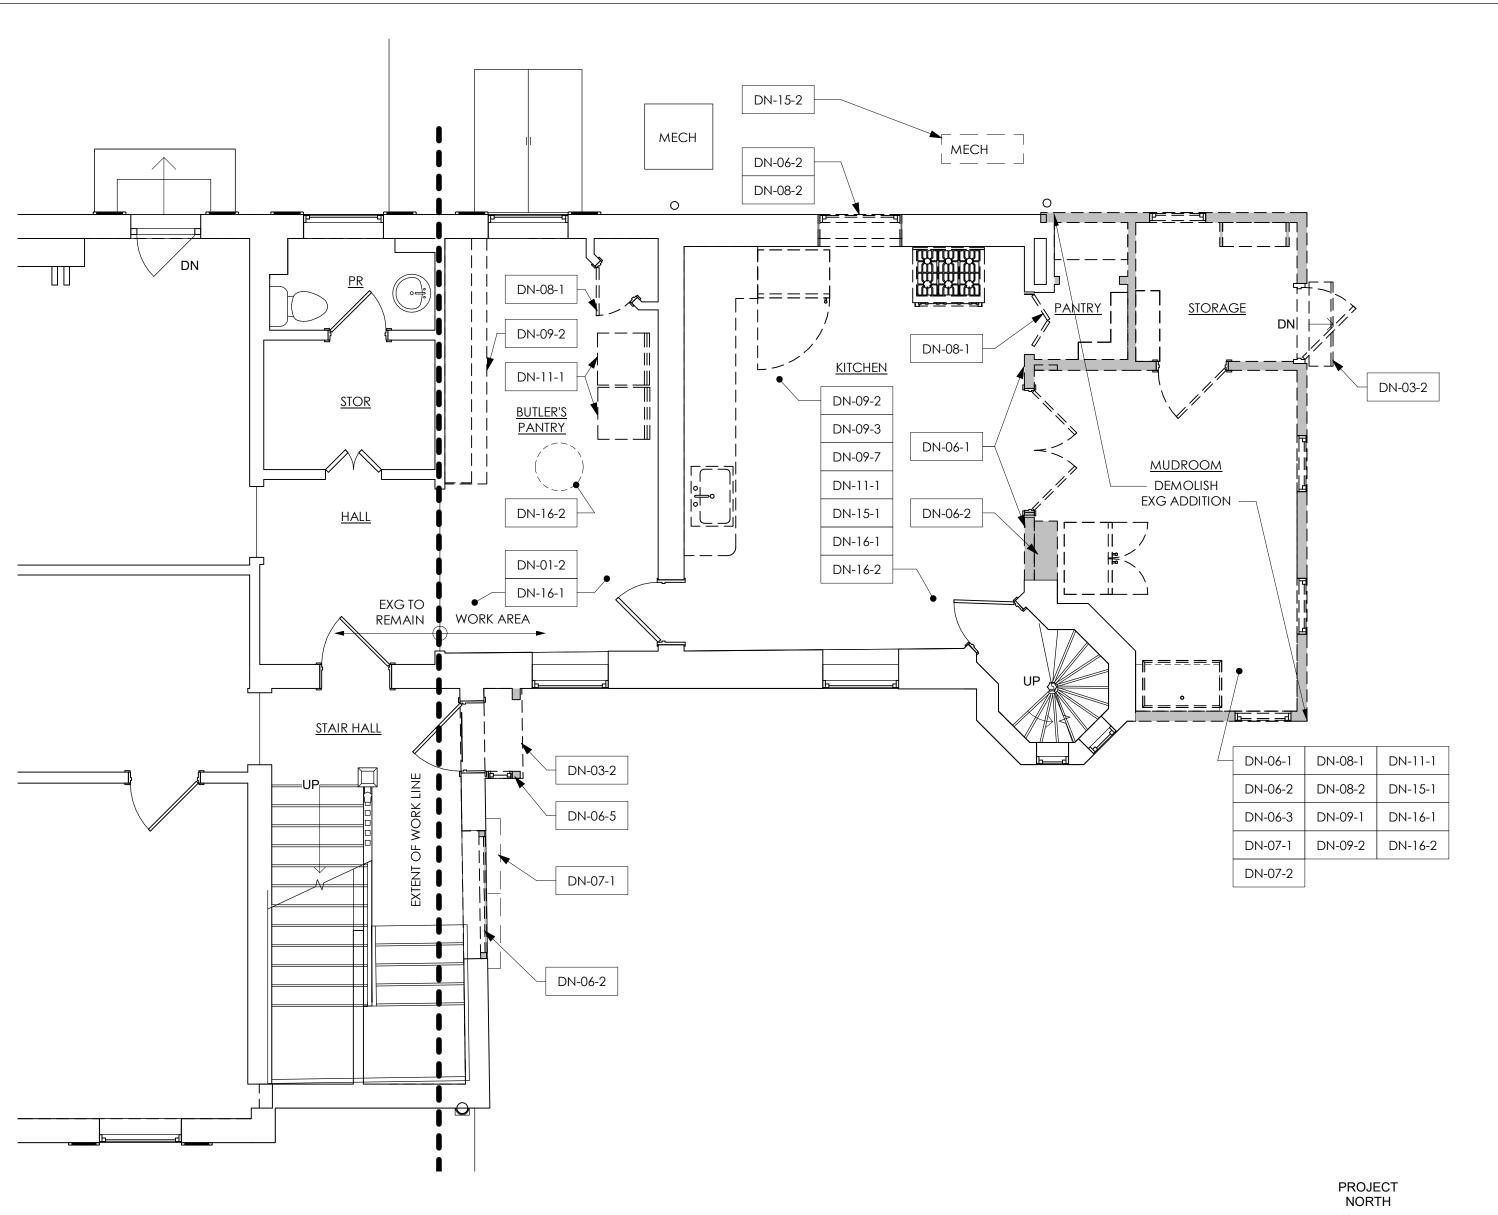

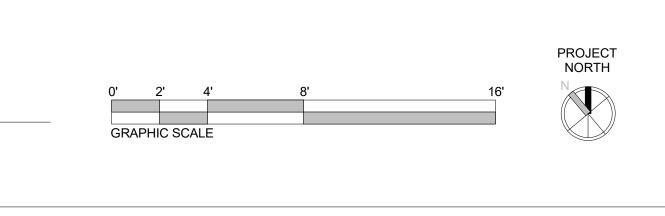

DEMOLITION PLAN LEGEND

FIRST FLOOR DEMOLITION

1 PLAN - PHASE A

A1.1 1/4" = 1'-0"

EXISTING ITEM TO BE DEMOLISHED


EXISTING WALL TO BE DEMOLISHED

EXISTING WALL TO REMAIN

GENERAL DEMOLITION NOTES

- SEE FLOOR PLAN FOR DIMENSIONS AND DETAILS OF PROPOSED OPENINGS IN EXISTING BUILDING.
- SALVAGE EXISTING DOORS FOR RE-USE, UNO.
- DEMOLITION WORK BY GC, UNO.
- ASSESS THE EXISTING MECHANICAL AND ELECTRICAL SYSTEMS TO VERIFY THAT EXISTING IS ADEQUATE TO SUPPORT PROPOSED WORK.
- 5. DEMOLITION PERMIT SET IS FOR NON-STRUCTURAL DEMOLITION ONLY.

| KEYNOTE NUMBER | DESCRIPTION OF WORK |
|-----------------------|---|
| DN-01-2 | EXISTING FLOORING TO REMAIN. |
| DN-03-2 | REMOVE EXISTING CONCRETE STAIR AND/OR LANDING. |
| DN-06-1 | REMOVE EXISTING INTERIOR PARTITION, INCLUDING WALL FRAMING AND FINISH MATERIAL. |
| DN-06-2 | REMOVE EXISTING EXTERIOR WALL INCLUDING FRAMING, SHEATHING, INSULATION AND FINISH MATERIALS. |
| DN-06-3 | REMOVE EXISTING CEILING AND/OR SOFFIT, INCLUDING FRAMING AND FINISH MATERIAL. |
| DN-06-4 | REMOVE EXISTING FURRED OUT PARTITION, INCLUDING FRAMING AND FINISH MATERIAL. |
| DN-06-5 | REMOVE EXISTING ENTRY SURROUND, WINDOW, SOFFIT, AND ROOF. |
| DN-07-1 | REMOVE EXISTING FINISH ROOFING MATERIAL, INCLUDING UNDERLAYMENT AND RELATED ROOF FLASHING. |
| DN-07-2 | REMOVE EXISTING GUTTERS AND DOWNSPOUTS, INCLUDING ALL HANGERS AND ACCESSORIES. |
| DN-08-1 | REMOVE DOOR, FRAME, AND HARDWARE. SEE GENERAL DEMOLITION NOTES FOR ADDITIONAL INFORMATION. |
| DN-08-2 | REMOVE WINDOW AND FRAME. SALVAGE FOR REUSE. |
| DN-09-1 | REMOVE EXISTING FLOOR FINISHES AND SUBFLOOR. |
| DN-09-2 | REMOVE EXISTING CABINETRY/CASEWORK. |
| DN-09-3 | REMOVE EXISTING WALL TILE. SALVAGE FOR REUSE. |
| DN-09-4 | REMOVE EXISTING WOOD WAINSCOT. SALVAGE FOR REUSE. |
| DN-09-5 | RETAIN HARDWOOD FLOORING AT UPPER LEVEL PRIMARY BATHROOM. PATCH AND REFINISH; PREPFLOOR TO RECEIVE SALVAGED AND PROPOSED MARBLE INSERTS BENEATH TOILET AND TUB. |
| DN-09-6 | REMOVE EXISTING MARBLE/STN FLOOR INSERTS. SALVAGE FOR REUSE. |
| DN-09-7 | REMOVE EXISTING FLOOR FINISHES AND PREP SUBFLOOR FOR PROPOSED WORK. |
| DN-11-1 | REMOVE EXISTING APPLIANCE(S) AND SALVAGE FOR REUSE. |
| DN-15-1 | REMOVE EXISTING PLUMBING FIXTURE AND/OR FAUCET. SALVAGE FOR REUSE. |
| DN-15-2 | REMOVE AND RELOCATE EXISTING MECHANICAL EQUIPMENT AS REQUIRED FOR PROPOSED WORK |
| DN-16-1 | REMOVE EXISTING ELECTRICAL DEVICES, SWITCHES, AND OUTLETS. |
| DN-16-2 | REMOVE EXISTING LIGHTING FIXTURES AND SALVAGE FOR REUSE. |

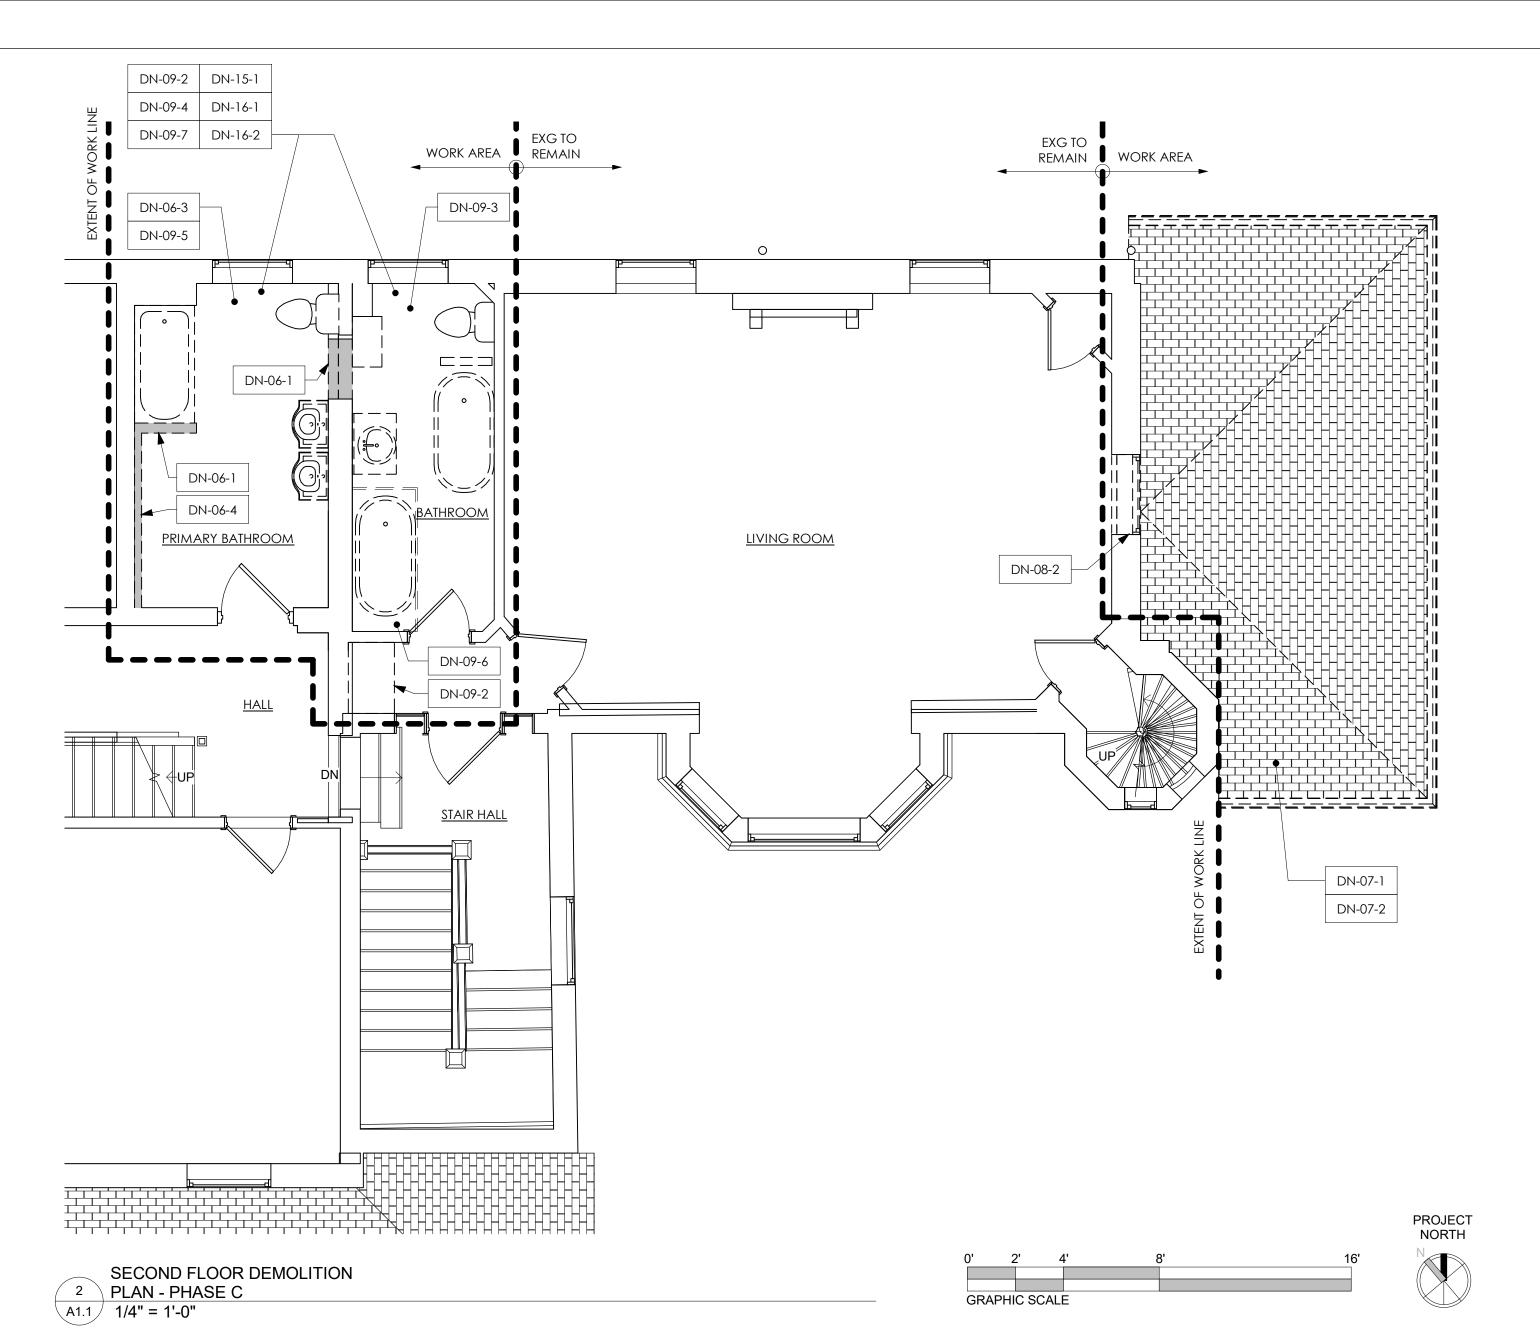

Work By Owner Schedule

ITEMS TO BE PURCHASED, DELIVERED AND INSTALLED BY OWNER UNO; CONTRACTOR TO COORDINATE SCHEDULE WITH OWNER THE FOLLOWING ITEMS ARE THE RESPONSIBILITY OF THE OWNER AND ARE NOT IN THE CONTRACT SUM: Description LANDSCAPING (AND ON-SITE STORM WATER MANAGEMENT LANDSCAPING (AND ON-SITE STORM WATER MANAGEMENT SYSTEM) TO BE PURCHASED AND INSTALLED BY OWNER. ROOFING (EXCLUDING SHEATHING) PROPOSED ROOFING, EXCLUDING SHEATHING, TO BE PURCHASED AND INSTALLED BY OWNER. APPLIANCES APPLIANCES TO BE PURCHASED AND INSTALLED BY OWNER. CABINETRY CABINETS TO BE PURCHASED BY OWNER AND INSTALLED BY CONTRACTOR OR OTHERS. SECURITY SYSTEM CONTRACTOR TO COORDINATE INSTALLATION BY OTHERS. CABLE/SATELITE DISH/DATA WIRING CABLE/SATELLITE DISH/DATA WIRING TO BE PURCHASED AND INSTALLED BY OWNER. AUDIO/VISUAL SYSTEM AUDIO/VISUAL SYSTEM, INCLUDING SPEAKERS AND WIRING, TO BE PURCHASED AND INSTALLED BY OWNER. WINDOW TREATMENTS BLINDS, DRAPES AND INTERIOR SHUTTERS TO BE PURCHASED AND INSTALLED BY OWNER. PRIMARY BATHROOM MIRROR PRIMARY BATHROOM MIRROR TO BE PROVIDED AND INSTALLED BY OWNER.

Alternate Schedule

AN ALTERNATE IS AN AMOUNT PROPOSED BY BIDDER FOR CERTAIN WORK THAT MAY BE ADDED TO OR DEDUCTED FROM THE BASE BID AMOUNT IF OWNER ACCEPTS THE ALTERNATE. THE COST OR CREDIT FOR EACH ALTERNATE IS THE ADDITION TO OR DEDUCTION FROM CONTRACT SUM TO INCOPORATE THE ALETERNATE INTO THE WORK. NO OTHER ADJUSTMENTS ARE MADE TO THE CONTRACT SUM. INDICATE ON THE BID FORM AMOUNTS TO BE DEDUCTED FROM OR ADDED TO CONTRACT SUM FOR THE FOLLOWING ALTERNATES.

| INDICATE ON THE BID FORM AMOUNTS TO BE DEDUCTED FROM ON ADDED TO CONTRACT SOME ON THE FOLLOWING ALTERNATES. | | |
|---|--|--|
| Item | Description | |
| ALTERNATE NUMBER 1 | PROVIDE IN-FLOOR HEATING AT GARAGE SLAB | |
| ALTERNATE NUMBER 2 | PROVIDE NEW WINDOWS AT MUDROOM ADDITION | |
| ALTERNATE NUMBER 3 | PROVIDE @ GARAGE 1ST FLOOR WALLS: 8" CMU W/ 3-5/8" MTL STUD FURRING; FILL FURRING CAVITIES W/ 2LB HIGH DENSITY CLOSED-CELL SPRAY FOAM INSULATION (R-20 MIN) + 5/8" GWB WALL FINISH | |

SIDENCE **RE**; a, PA, US ARRAGUT Street Philodoletic

KEY PLAN:

CONSULTANTS:

CONSULTANTS:

ARCHITECT PROJECT NUMBER: 2307 ISSUE DATE:

STATUS:

JANUARY 10, 2025

PHC APPLICATION

REVISION DATE:

SHEET TITLE: **DEMOLITION PLANS & SCHEDULES**

SHEET NUMBER:

